

ISSUED FOR BID TOWN OF CLINTON LIBRARY HANDICAP RAMP AND ENTRY IMPROVEMENTS

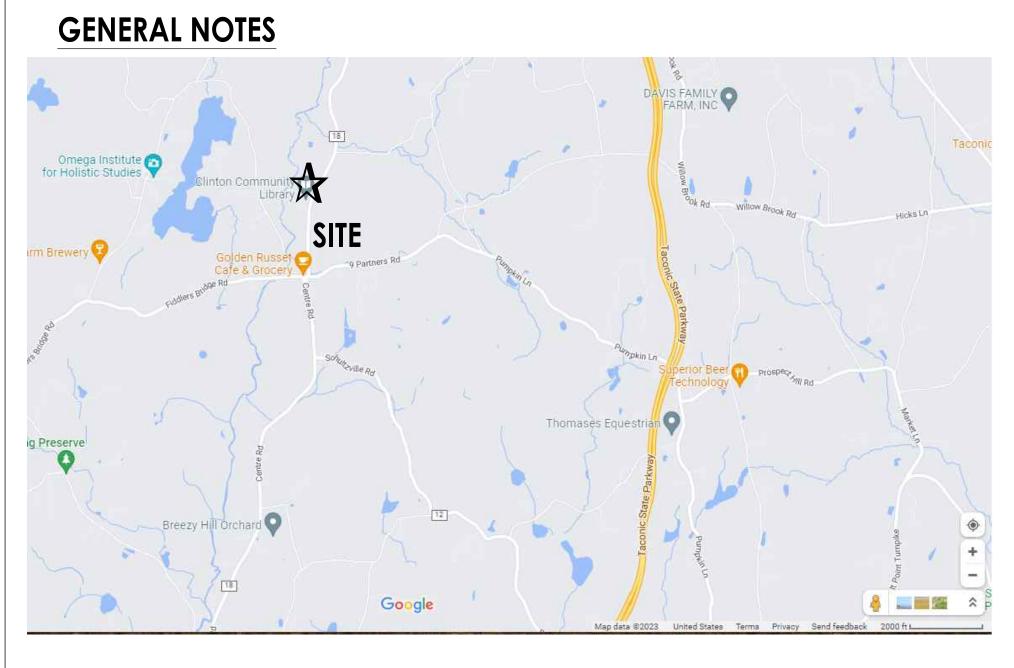

1215 CENTRE ROAD TOWN OF CLINTON DUTCHESS COUNTY NEW YORK

COMMUNITY LIBRARY

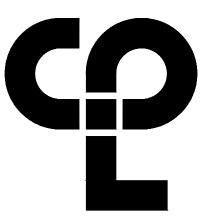

CPL | Architecture Engineering Planning 26 IBM Road Poughkeepsie, NY 12601 CPLteam.com

PROJECT INFORMATION Project Number 14968.06 Client Name TOWN OF CLINTON

Project Name LIBRARY HANDICAP RAMP AND ENTRY IMPROVEMENTS COMMUNITY LIBRARY

Project Address 1215 CENTRE ROAD TOWN OF CLINTON DUTCHESS COUNTY NEW YORK

PROJECT ISSUE & REVISION SCHEDULE
No. Date Description

PROFESSIONAL STAMPS

GENERAL NOTES

THE DESIGN OF THIS PROJECT CONFORMS TO ALL APPLICABLE PROVISIONS OF NEW YORK STATE UNIFORM FIRE PREVENTION AND BUILDING CODE, THE NEW YORK STATE ENERGY CONSERVATION CODE, AND THE MANUAL OF PLANNING STANDARDS OF THE NEW YORK STATE EDUCATION DEPARTMENT.

SHEET LIST

T000TITLE SHEETA100DEMOLITION PLANA200FOOTINGS & FLATWORK PLANSA201STRUCTURAL FRAMING PLANA202DECK PLANA500DECK DETAILSA501ENTRANCE DETAILS

FOR REVIEW ONLY NOT FOR PERMIT OR CONSTRUCTION

IT IS A VIOLATION OF THE NEW YORK STATE EDUCATION LAW ANL REGULATIONS FOR ANY PERSON, UNLESS ACTING UNDER THE DIR. ARCHITECT, ENGINEER OR LAND SURVEYOR, TO ALTER AN ITEM IN BEARING THE SEAL OF AN ARCHITECT, ENGINEER OR SURVEYOR IS PARTY SHALL AFFIX TO THE ITEM THER SEAL AND THE NOTATION "A. THER SIGNATURE AND THE DATE OF SUCH ALTERATION, AND A SPL ALTERATION.

NEW YORK STATE EDUCATIO


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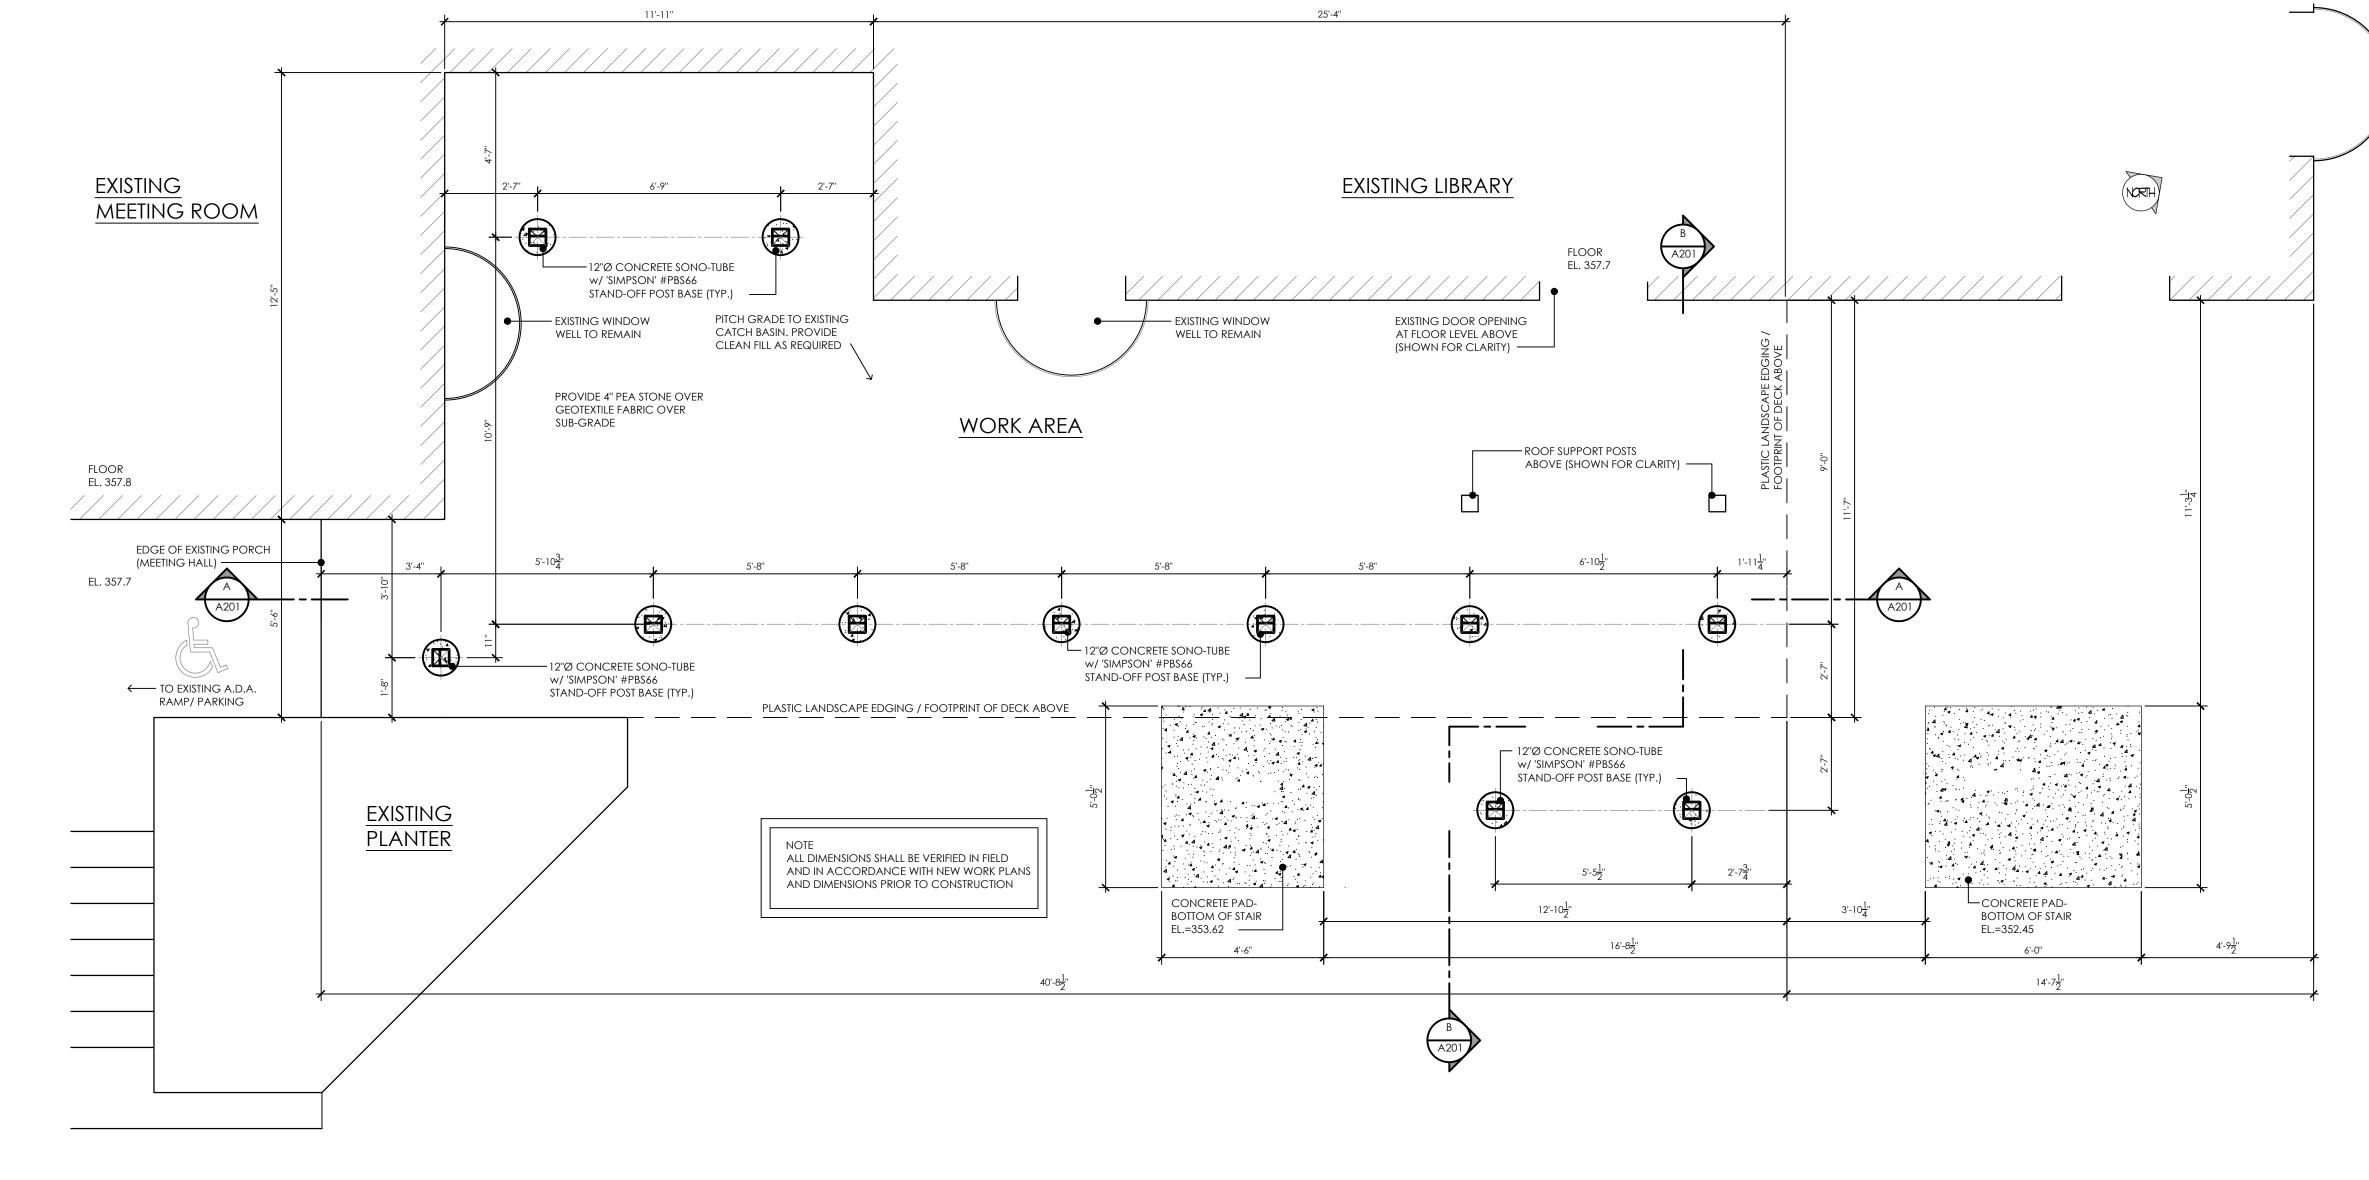
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SCALE: 1/16"=1'-0"





SCALE: 3/8"=1'-0"

1215 CENTRE ROAD TOWN OF CLINTON DUTCHESS COUNTY NEW YORK

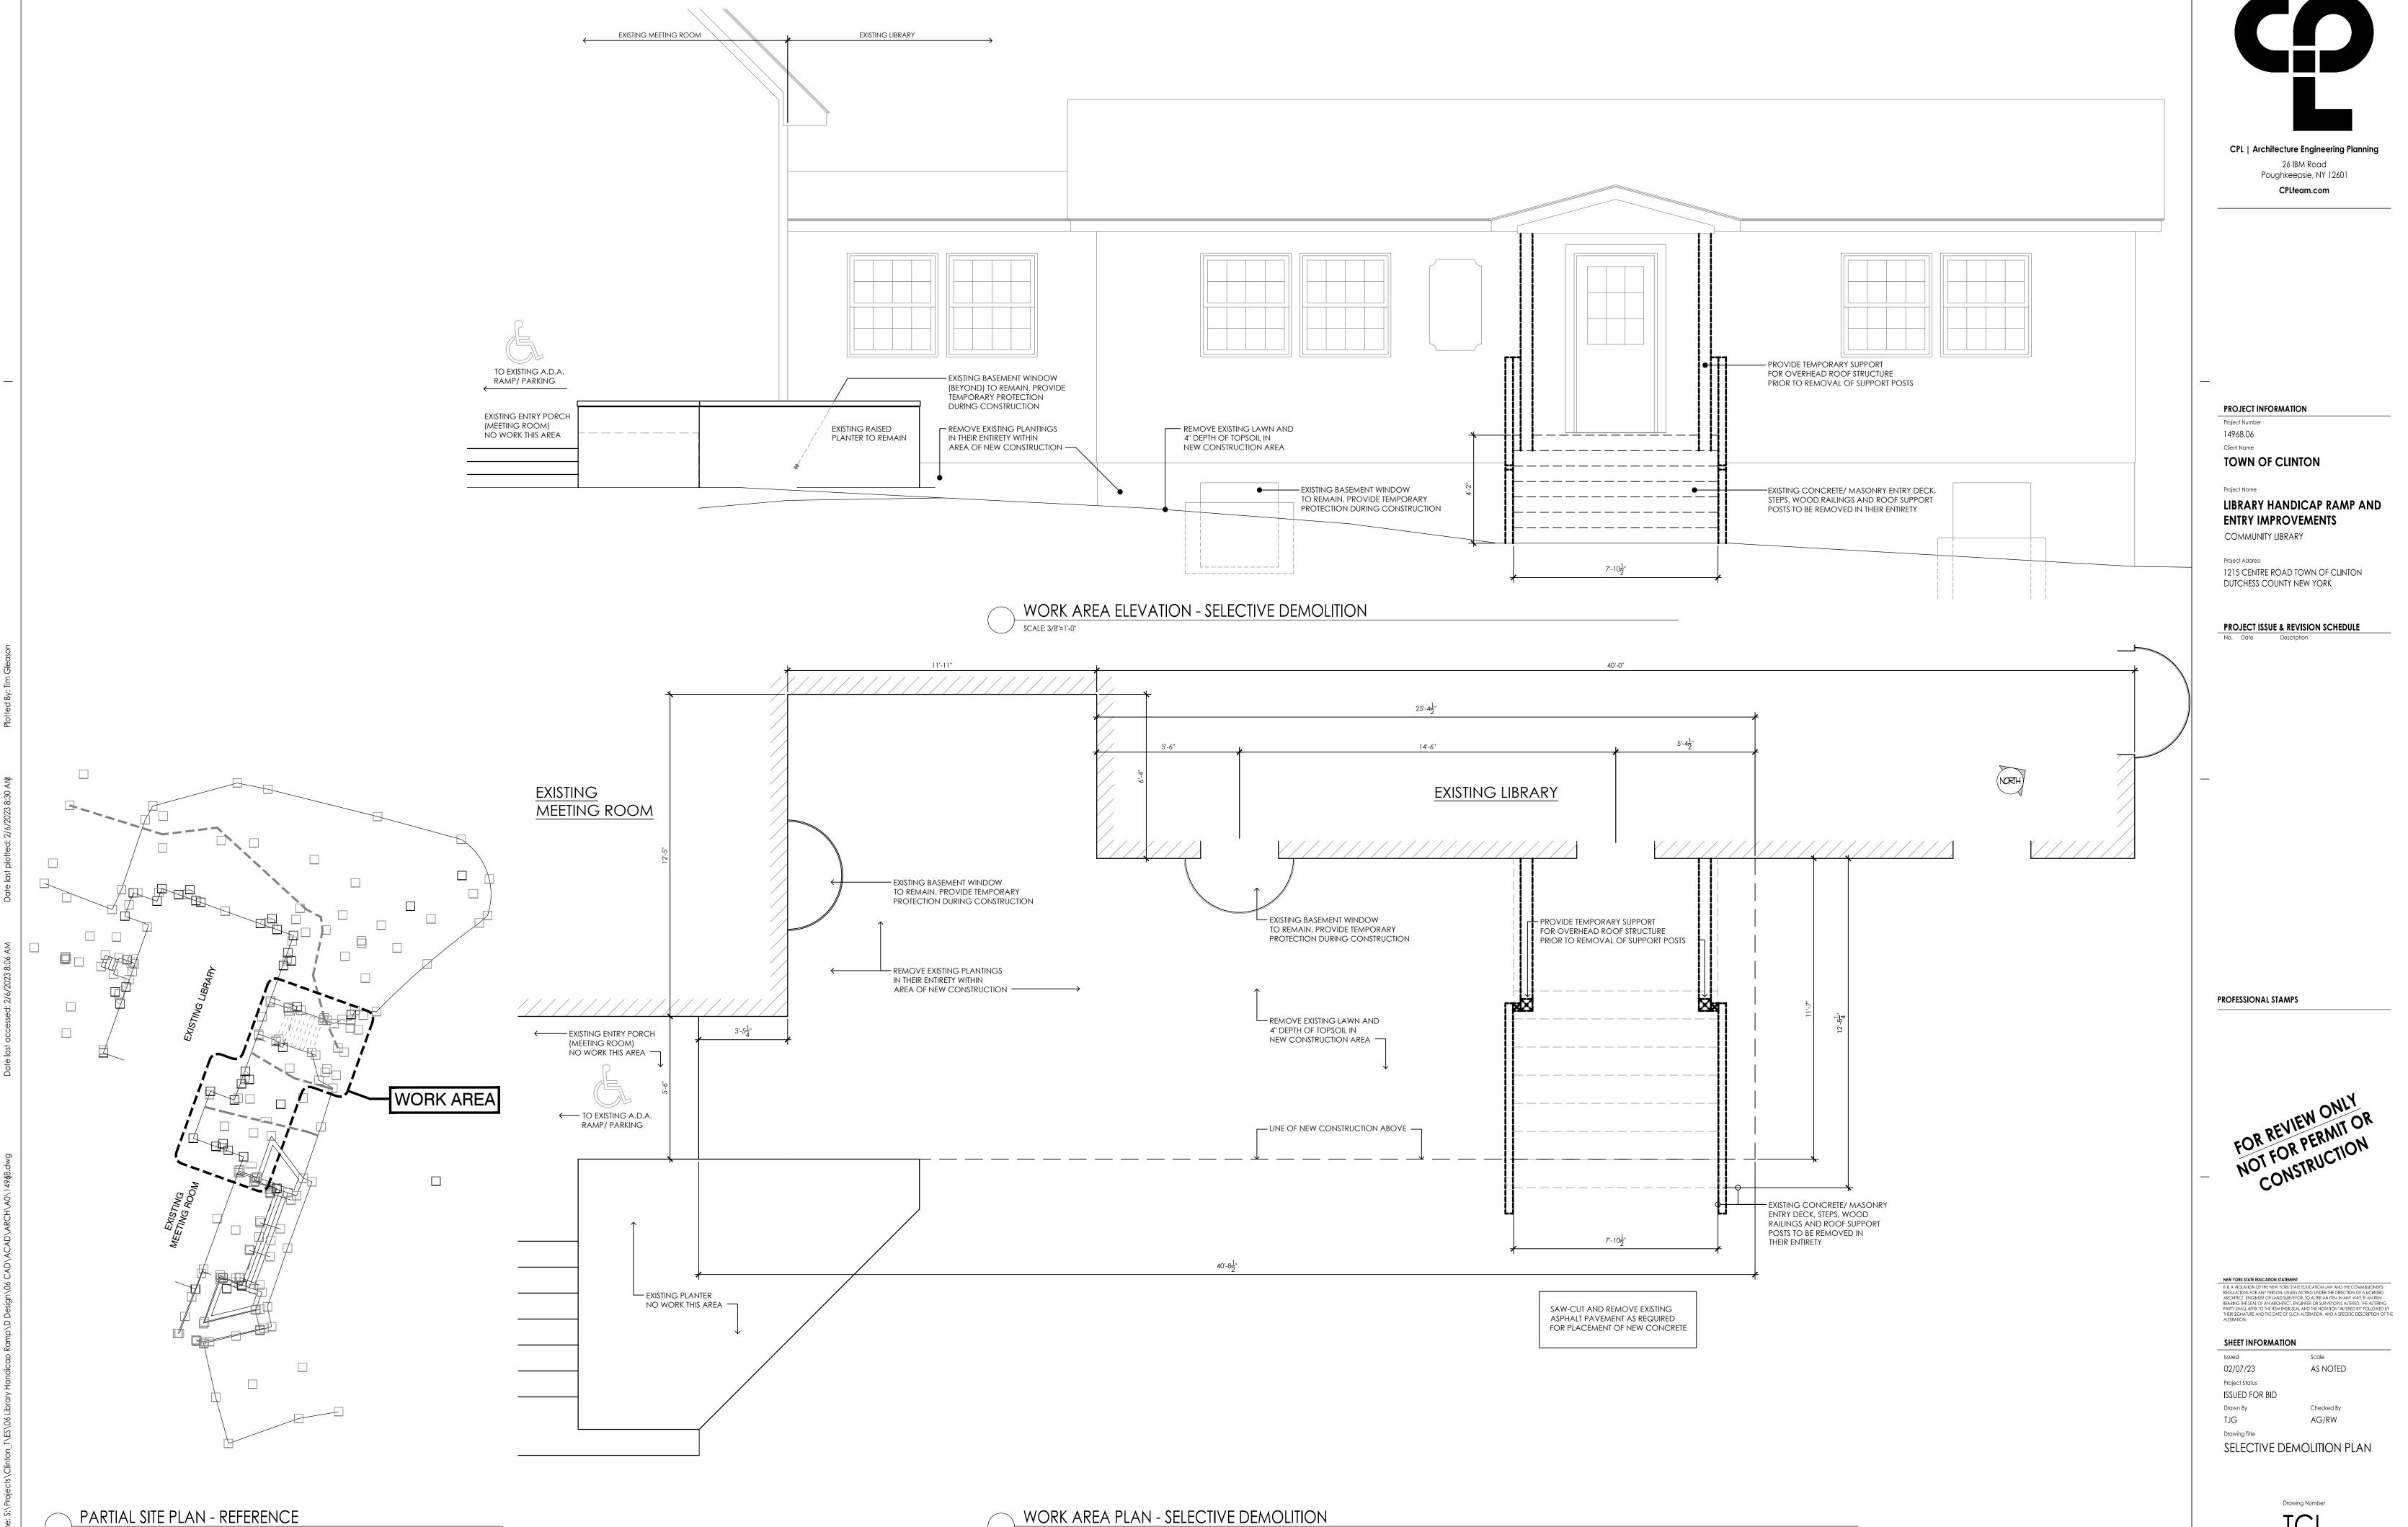LIBRARY HANDICAP RAMP AND

PROJECT INFORMATION

TOWN OF CLINTON

ENTRY IMPROVEMENTS

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PROFESSIONAL STAMPS



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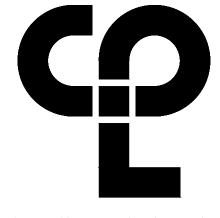
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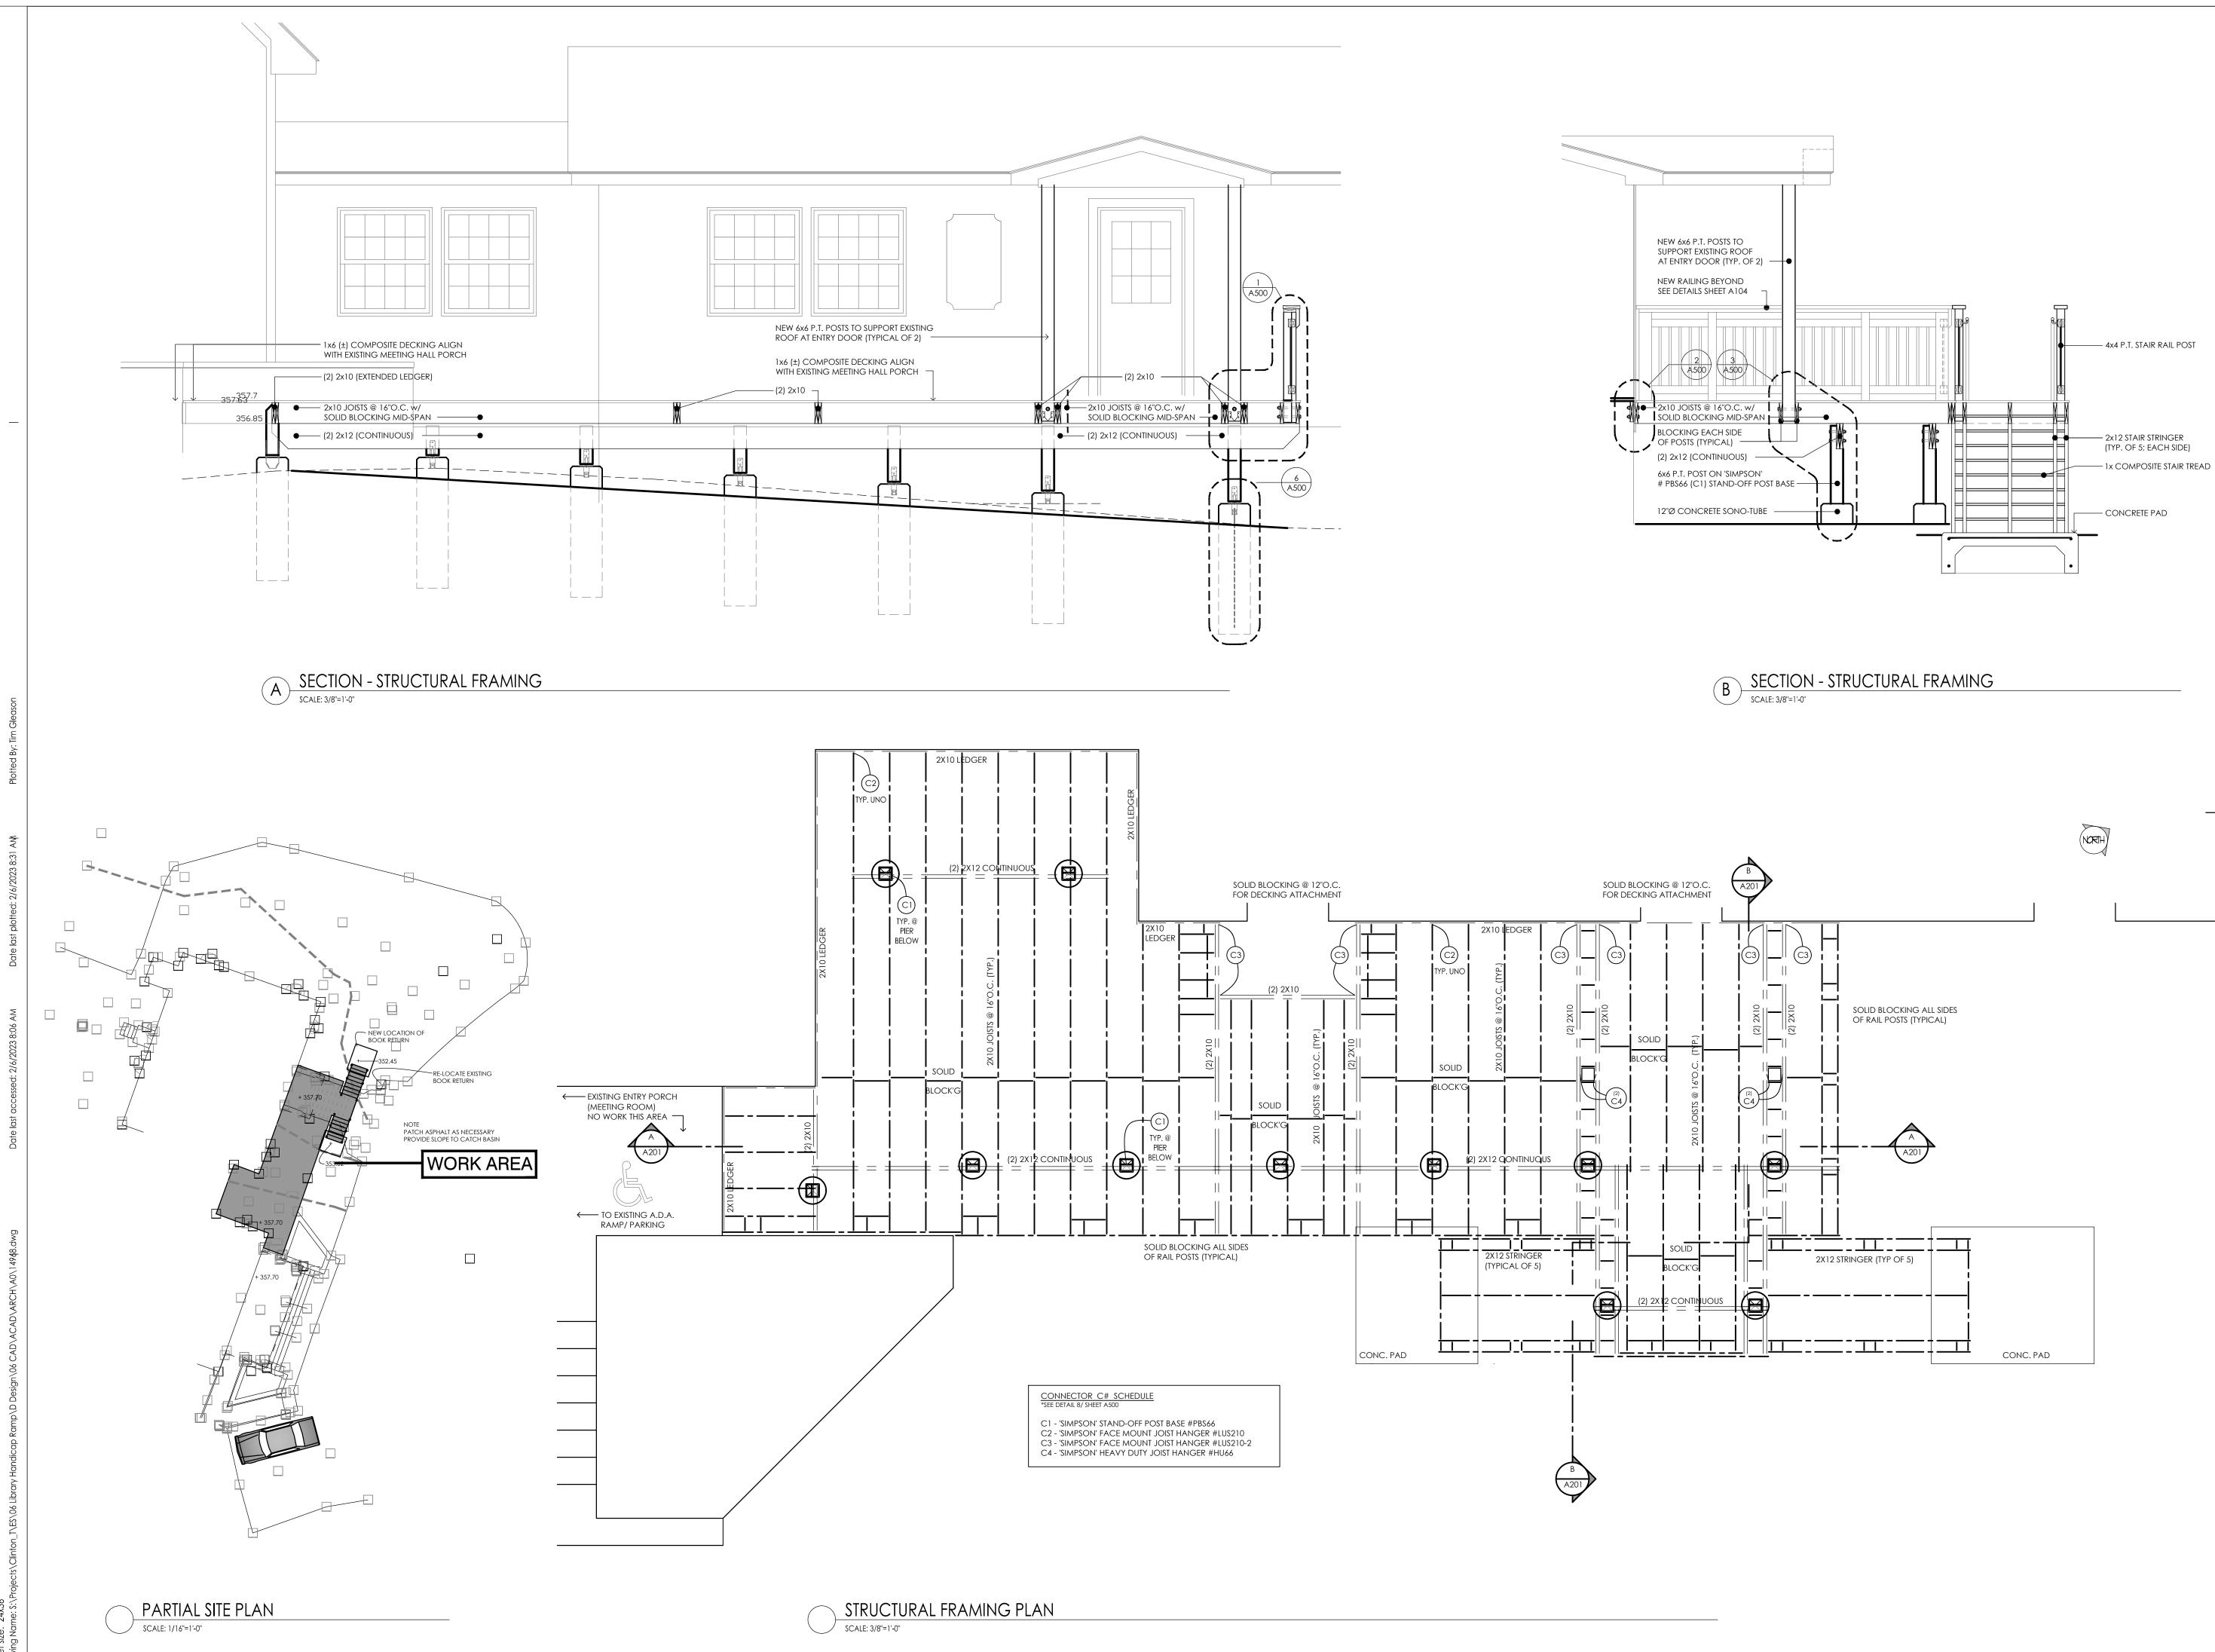
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 Drawing Tifle
 FOOTINGS & FLATWORK PLAN





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PROJECT INFORMATION Project Number 14968.06

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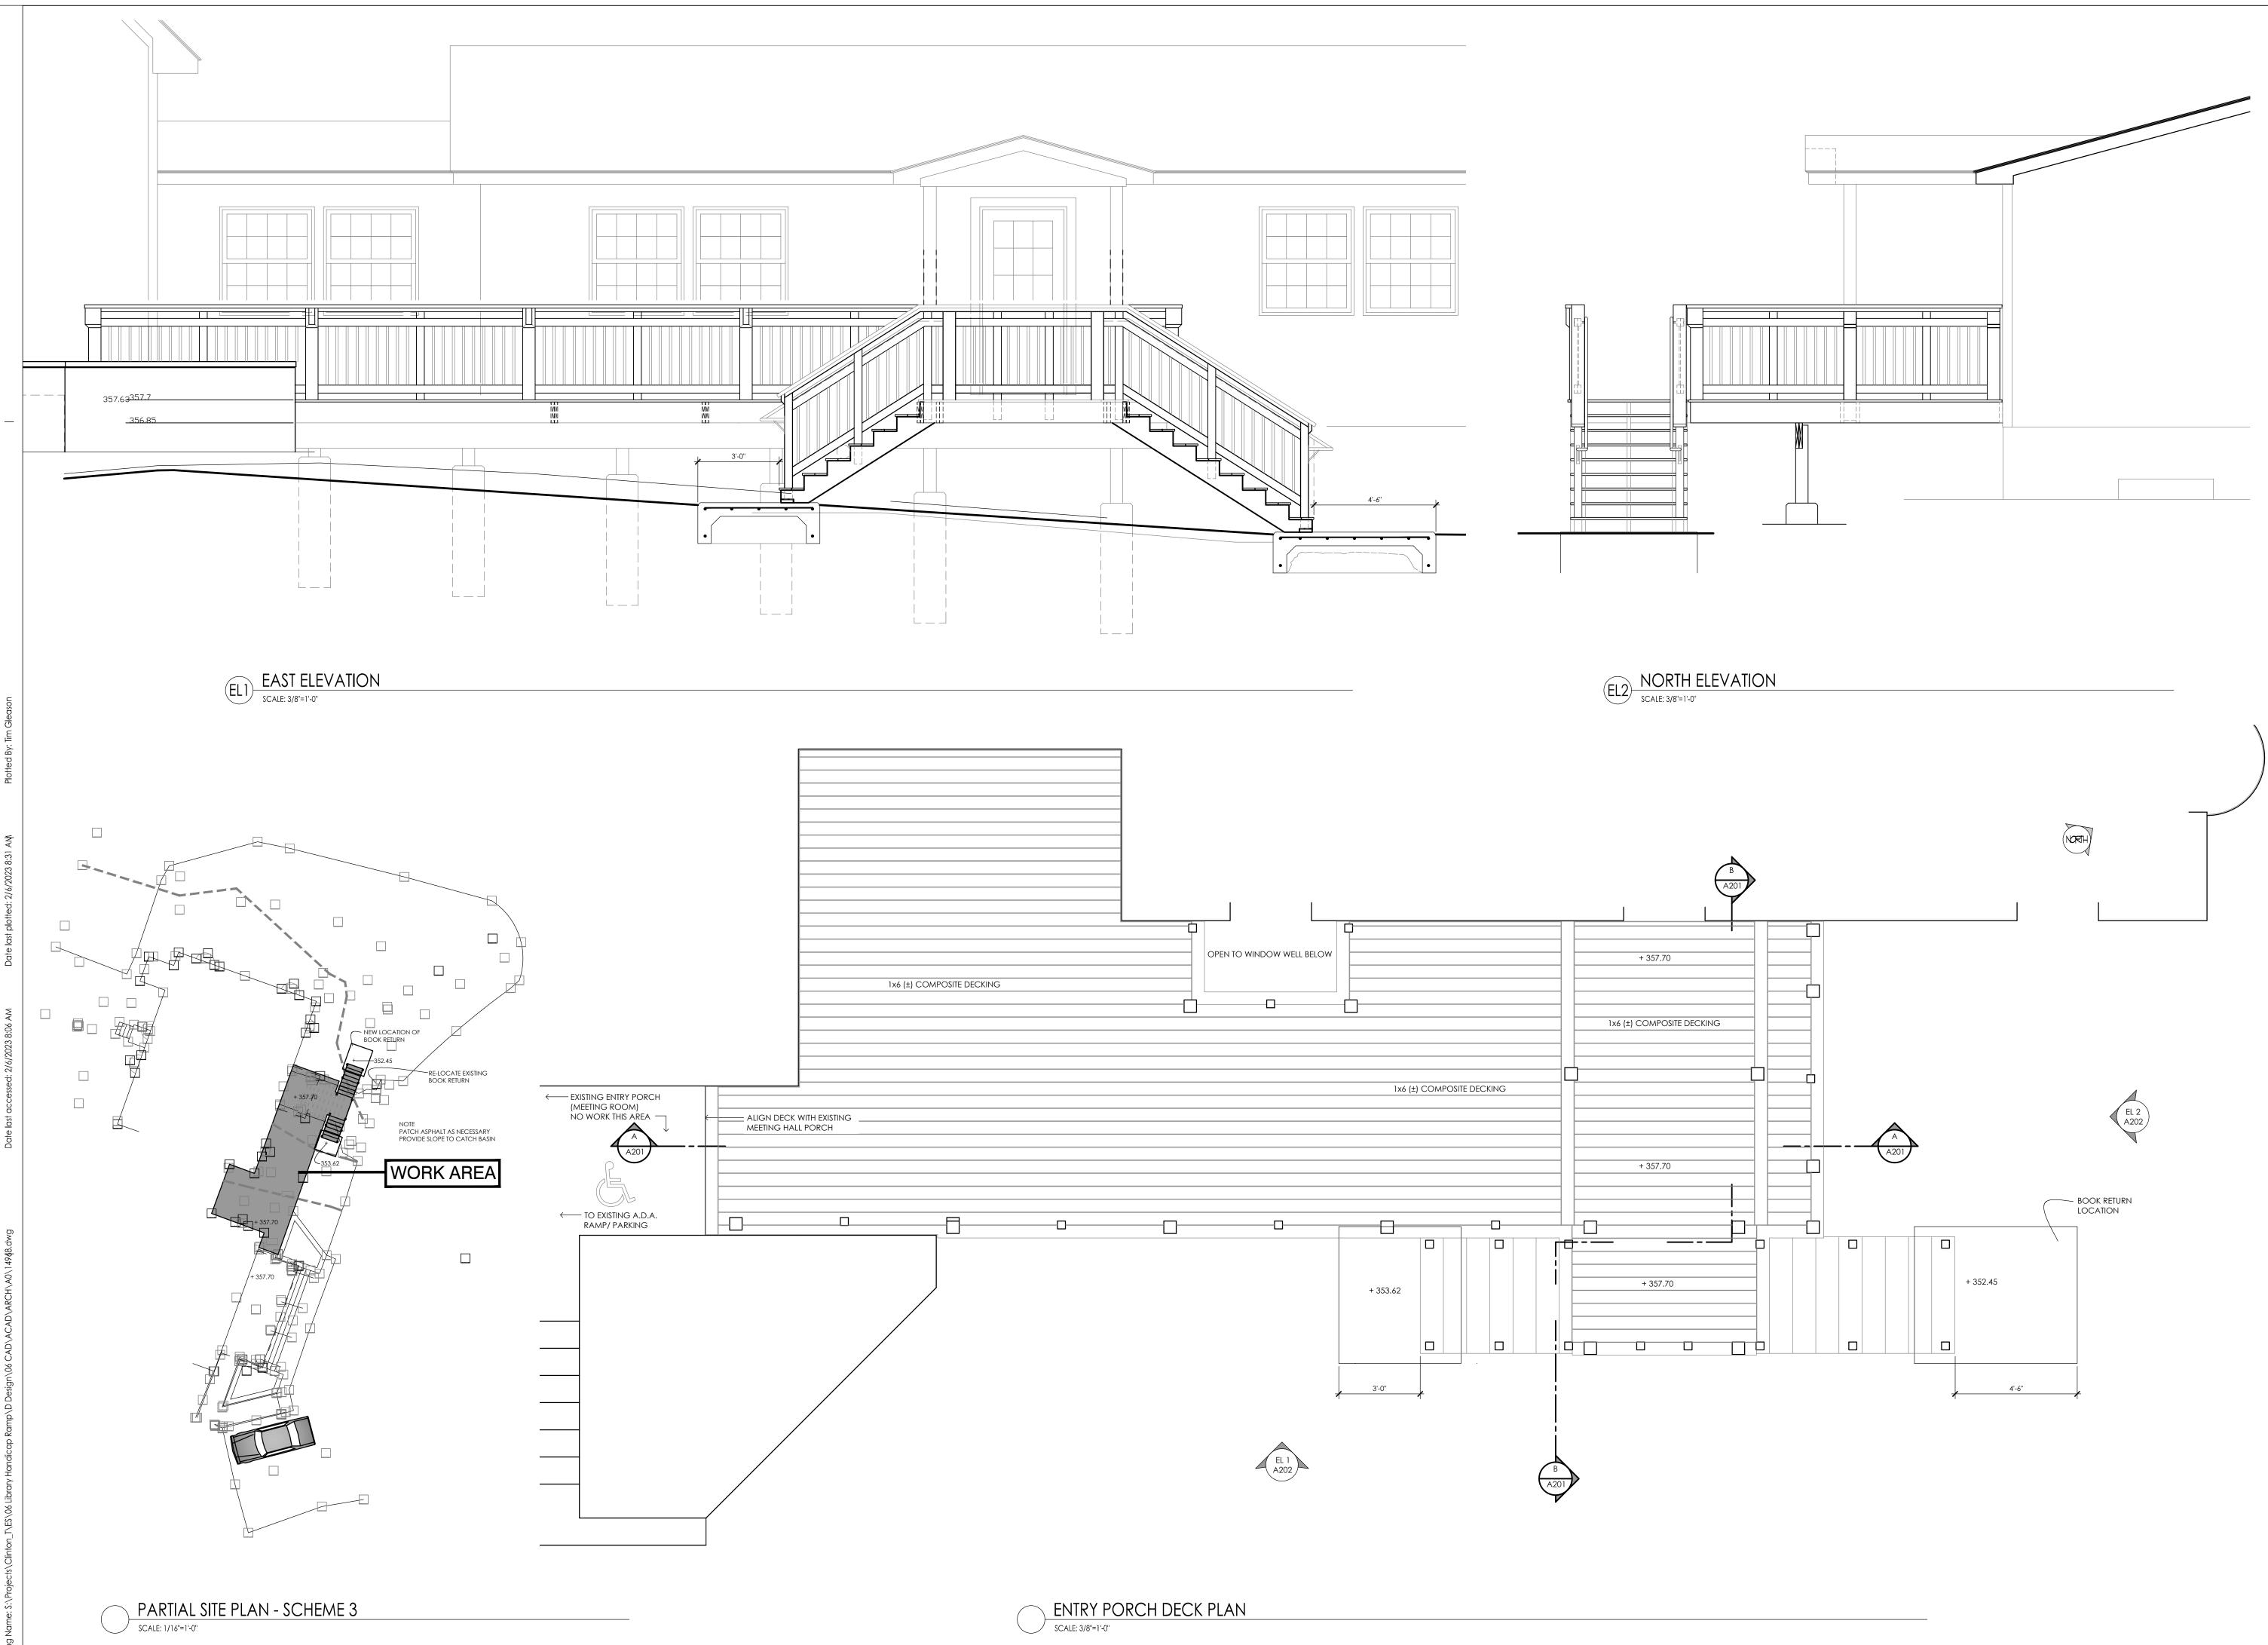
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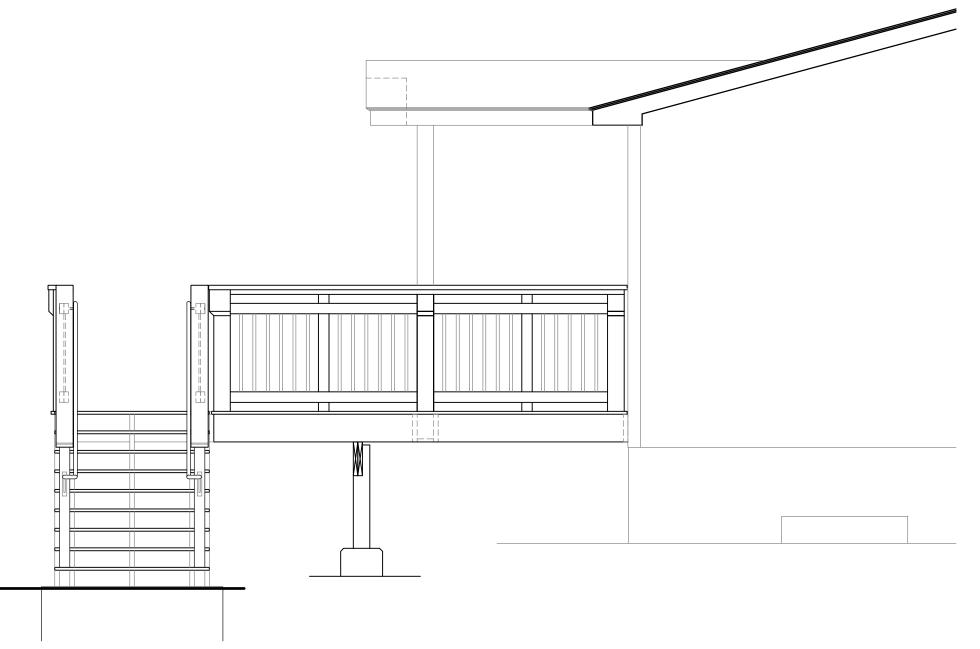
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STRUCTURAL FRAMING PLAN







PROFESSIONAL STAMPS



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Issued 02/07/23 Project Status ISSUED FOR BID Drawn By TJG Drawing Title DECK PLAN

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Drawing Number TCL A202

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PROJECT INFORMATION

TOWN OF CLINTON

ENTRY IMPROVEMENTS

COMMUNITY LIBRARY

LIBRARY HANDICAP RAMP AND

1215 CENTRE ROAD TOWN OF CLINTON DUTCHESS COUNTY NEW YORK

 PROJECT ISSUE & REVISION SCHEDULE


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 Description

Project Number 14968.06 Client Name

Project Name

Project Address

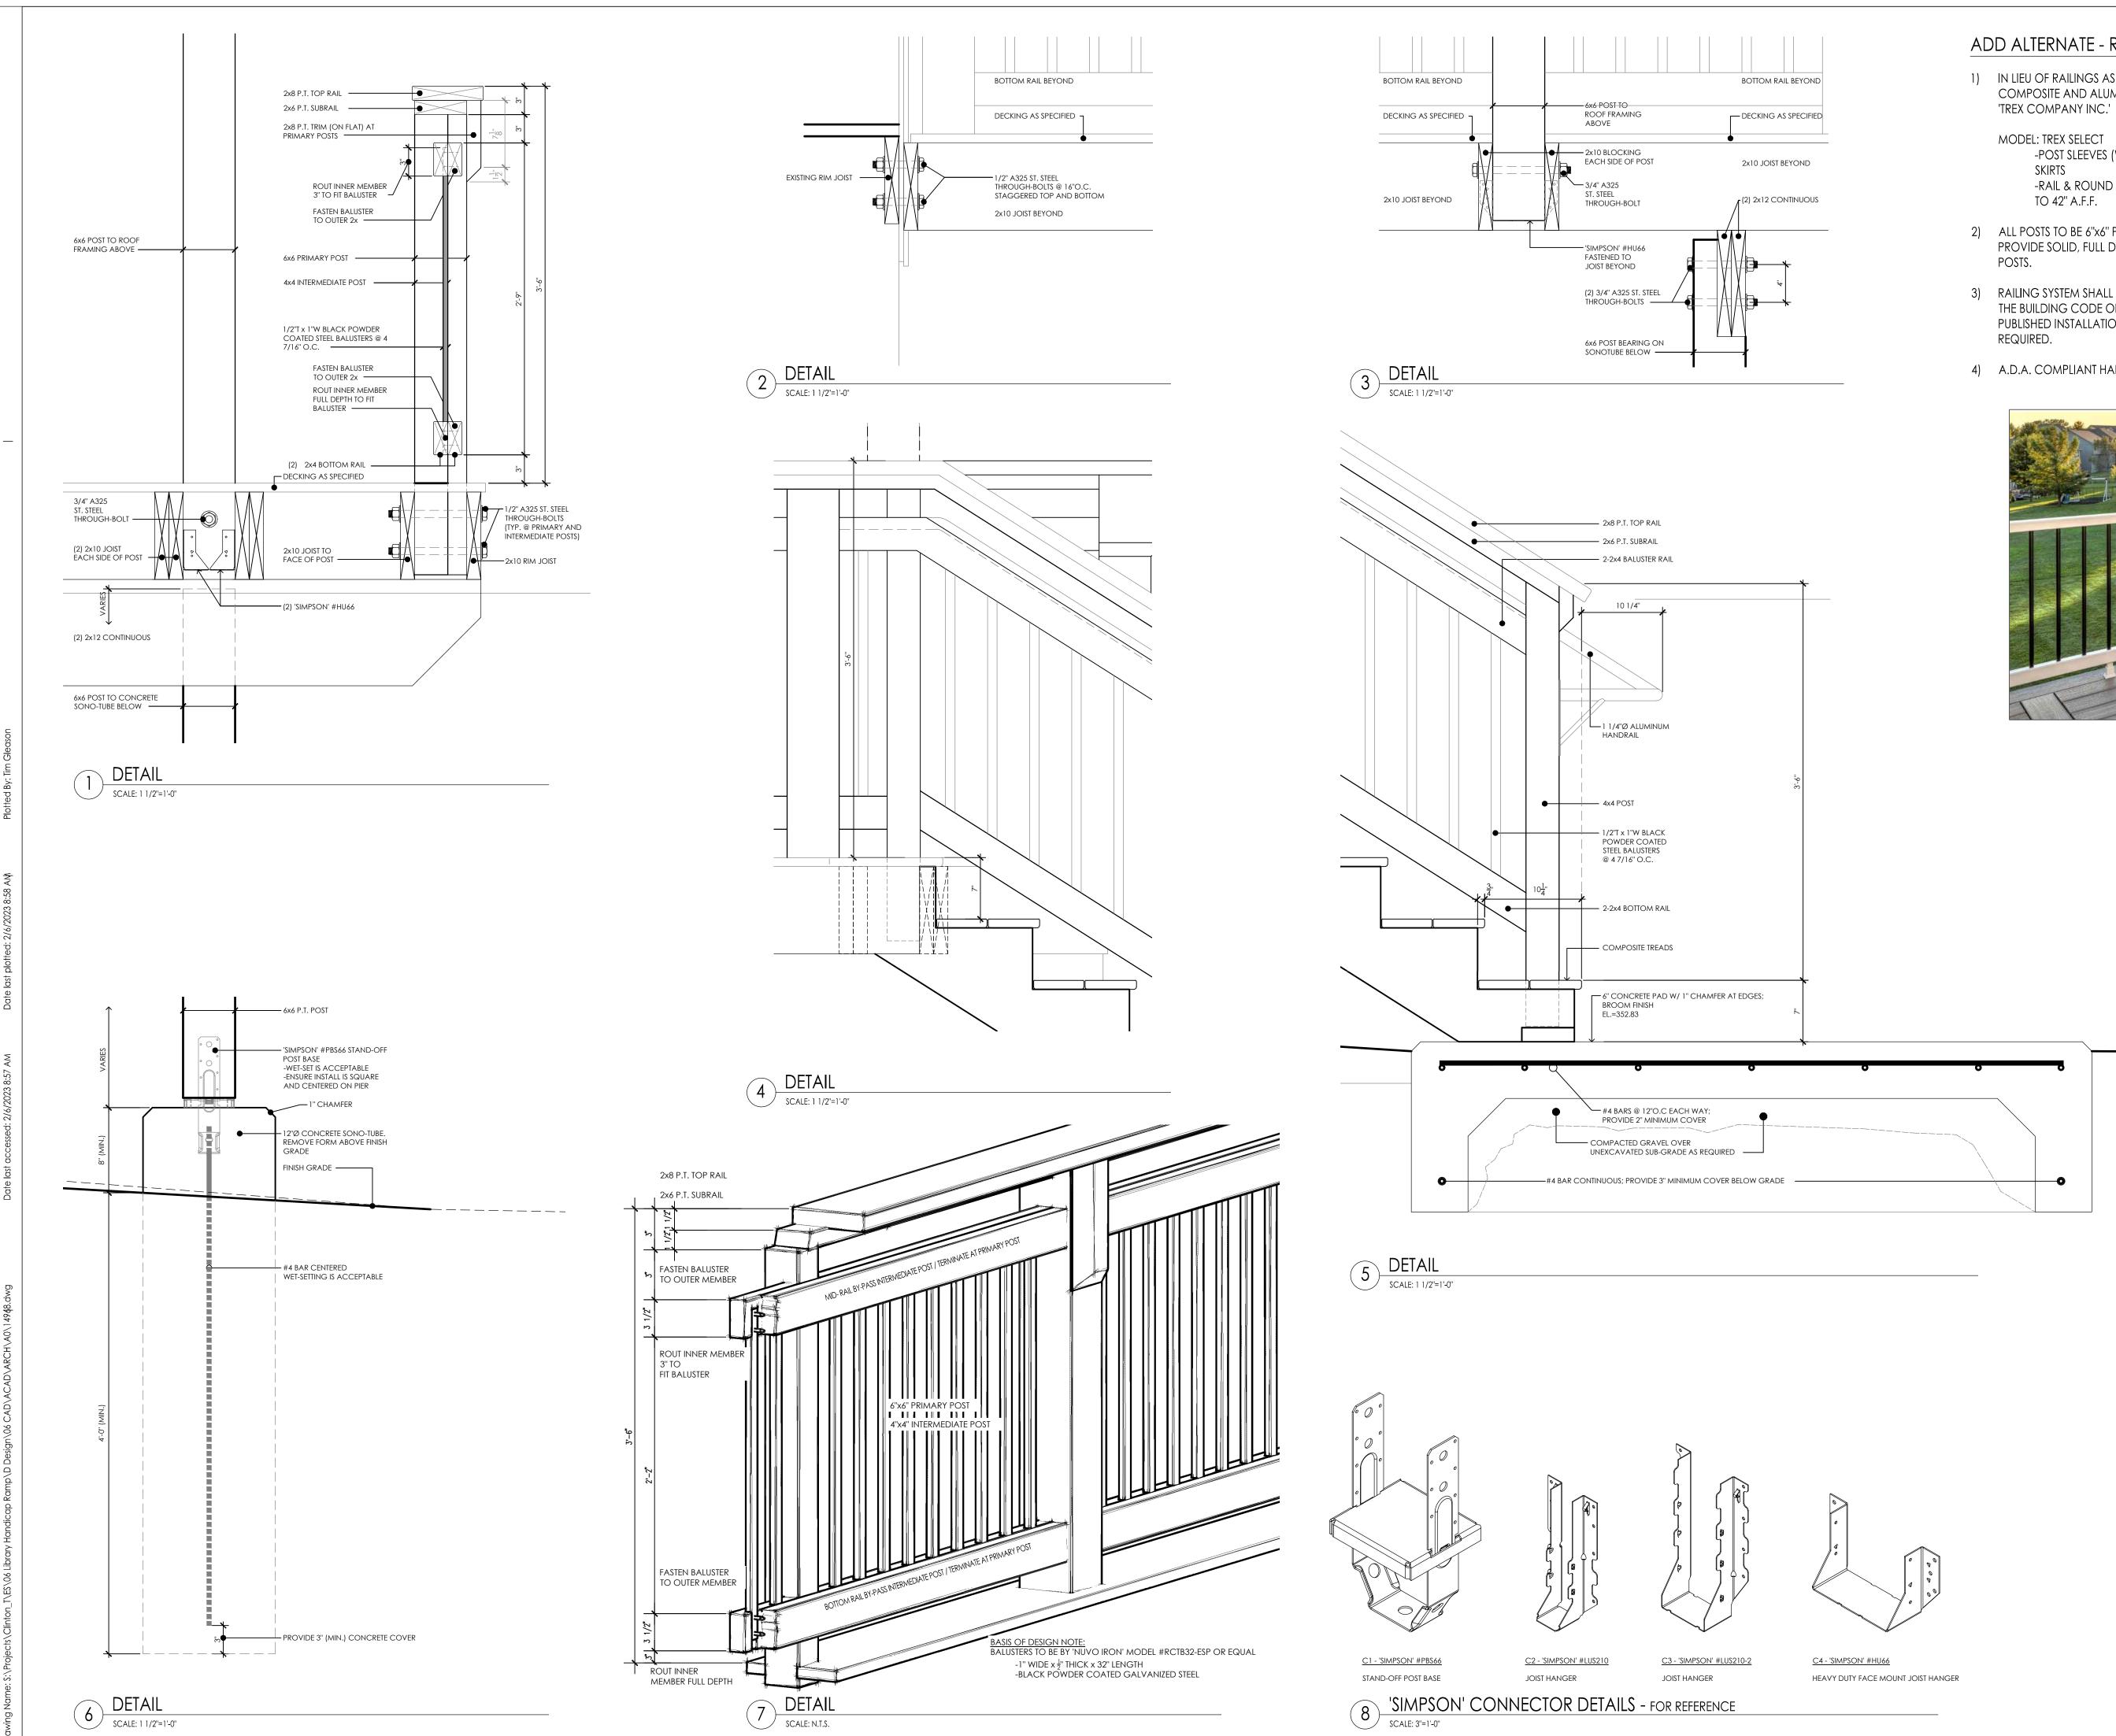

ADD ALTERNATE - RAILING

1) IN LIEU OF RAILINGS AS SHOWN HEREON, PROVIDE AND INSTALL COMPOSITE AND ALUMINUM RAILING SYSTEM AS MANUFACTURED BY

- -POST SLEEVES (WHITE) TO 45" A.F.F. w/ SLEEVE CAPS AND
- -RAIL & ROUND ALUMINUM BALUSTER KIT (WHITE/ BLACK)
- 2) ALL POSTS TO BE 6"x6" PRESSURE-TREATED AT 6'-0" O.C. (MAX.) PROVIDE SOLID, FULL DEPTH BLOCKING AND/OR JOIST ALL SIDES OF
- 3) RAILING SYSTEM SHALL BE INSTALLED IN STRICT ACCORDANCE WITH THE BUILDING CODE OF NEW YORK STATE AND THE MANUFACTURER'S PUBLISHED INSTALLATION INSTRUCTIONS. ADJUST POST SPACING AS
- 4) A.D.A. COMPLIANT HANDRAILS SHALL BE PROVIDED WHERE INDICATED.





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PROJECT INFORMATION Project Number 14968.06 Client Name

TOWN OF CLINTON

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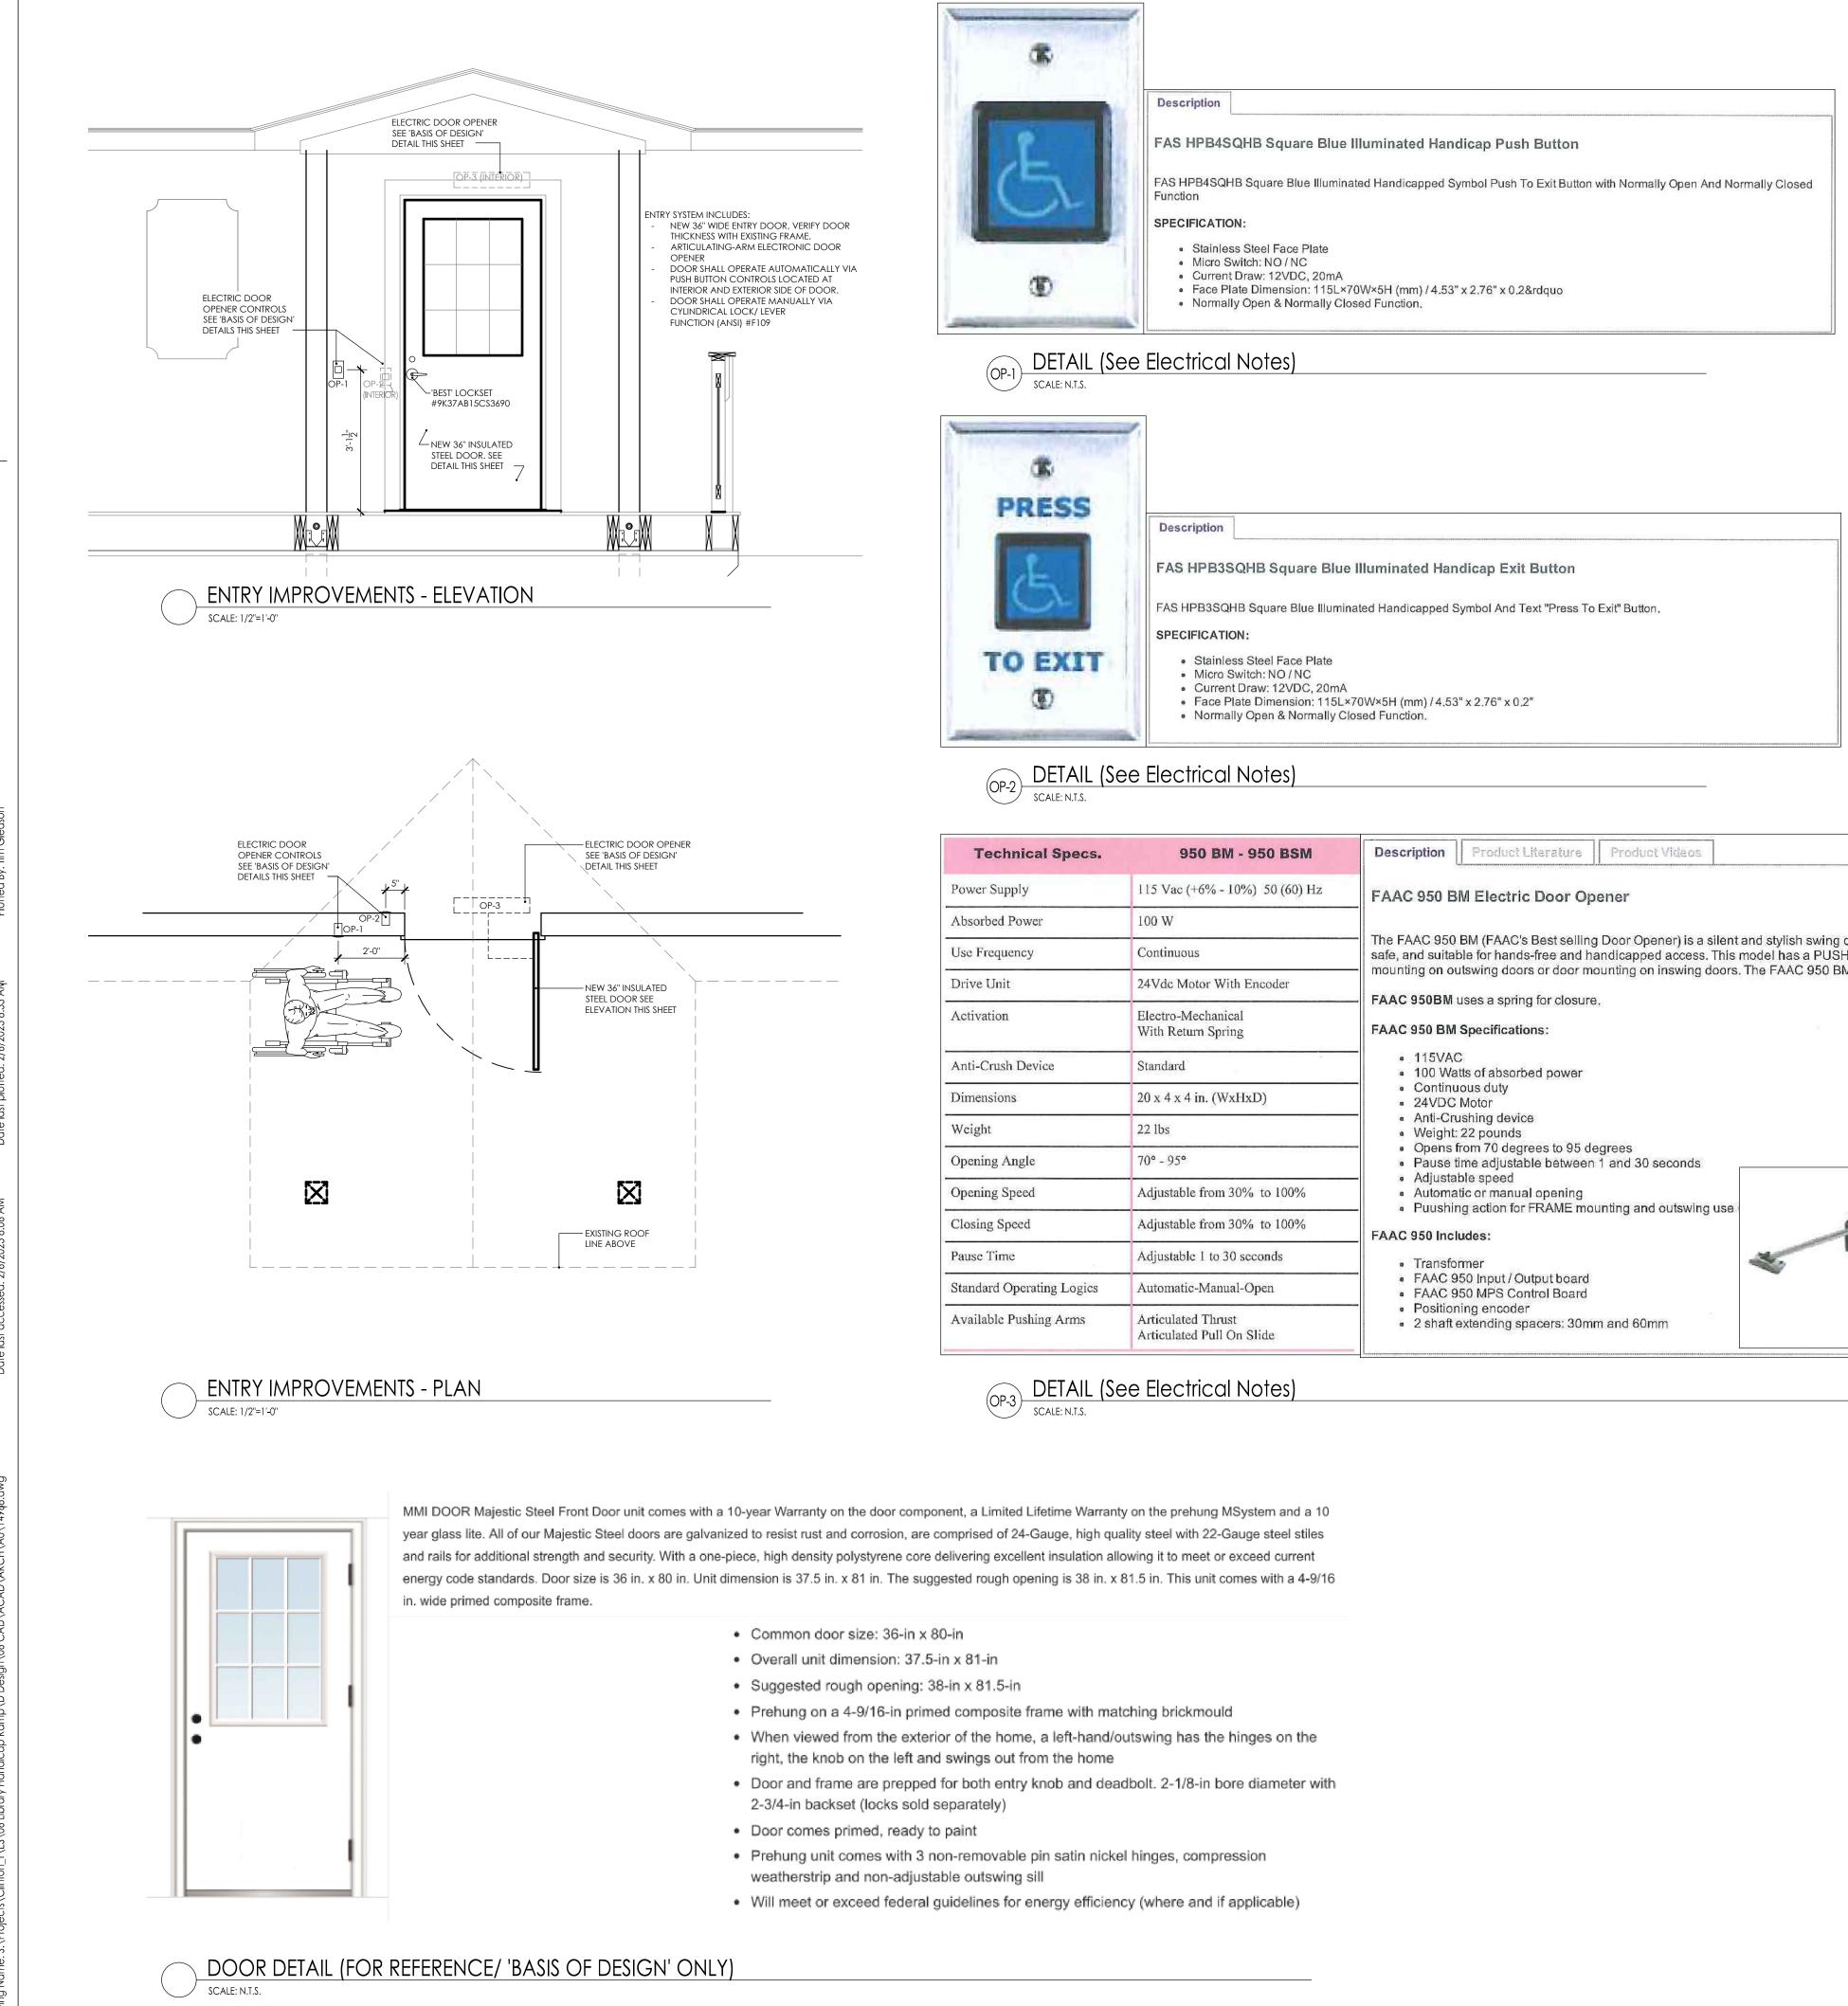
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NEW YORK STATE EDUCATION STATEMENT

Issued 02/07/23 Project Status ISSUED FOR BID Drawn By tjg Drawing Title DECK DETAILS

Scale AS NOTED Checked By AG/RW





nical Specs.	950 BM - 950 BSM	Description Product Literature Product Videos		
ply	115 Vac (+6% - 10%) 50 (60) Hz	FAAC 950 BM Electric Door Opener		
Power	100 W			
ency	Continuous	The FAAC 950 BM (FAAC's Best selling Door Opener) is a silent and stylish swing door opening and closing unit that is reliable, safe, and suitable for hands-free and handicapped access. This model has a PUSHING ARTICULATING arm which is for frame		
	24Vdc Motor With Encoder	 mounting on outswing doors or door mounting on inswing doors. The FAAC 950 BM model is a spring-based system. FAAC 950BM uses a spring for closure. FAAC 950 BM Specifications: 		
	Electro-Mechanical With Return Spring			
Device	Standard	 115VAC 100 Watts of absorbed power 		
S	20 x 4 x 4 in. (WxHxD)	 Continuous duty 24VDC Motor 		
	22 lbs	 Anti-Crushing device Weight: 22 pounds 		
ngle	70° - 95°	 Opens from 70 degrees to 95 degrees Pause time adjustable between 1 and 30 seconds 		
beed	Adjustable from 30% to 100%	 Adjustable speed Automatic or manual opening Description for FDAME recurrities and output in the second output in the		
eed	Adjustable from 30% to 100%	Puushing action for FRAME mounting and outswing use FAAC 950 Includes:		
	Adjustable 1 to 30 seconds	Transformer FAAC 950 Input / Output board FAAC 950 MPS Control Board		
perating Logics	Automatic-Manual-Open			
ushing Arms	Articulated Thrust Articulated Pull On Slide	Positioning encoder 2 shaft extending spacers: 30mm and 60mm		

GENERAL CONDITIONS

- ALL WORK AND MATERIALS SHALL COMPLY WITH THE BUILDING CODE OF NEW YORK STATE, LOCAL BUILDING CODES, ENERGY CONSERVATION CONSTRUCTION CODE OF NEW YORK STATE, THE NATIONAL ELECTRIC CODE, NATIONAL BOARD OF FIRE UNDERWRITERS CODE, THE REQUIREMENTS OF THE COUNTY BOARD OF HEALTH AND ANY OTHER APPLICABLE CODES AND/OR REGULATIONS.
- ANYTHING NOT SPECIFICALLY SHOWN HEREON AND/OR IN THE SPECIFICATIONS, BUT IS REASONABLY IMPLIED, SHALL BE FURNISHED AS THOUGH SET FORTH IN THE PLANS AND/OR SPECIFICATIONS. ALL WRITTEN FIGURES, NOTES AND DIMENSIONS ON THE PLANS OR SPECIFICATIONS SHALL TAKE PRECEDENCE OVER ANY DRAWN FIGURE. DO NOT SCALE PRINTS. ALL DIMENSIONS SHALL BE FIELD VERIFIED BY THE CONTRACTOR PRIOR TO THE START OF ANY CONSTRUCTION. ANY DISCREPANCIES SHALL BE REPORTED TO THE ENGINEER PRIOR TO THE START OF CONSTRUCTION.
- ALL REQUIRED PERMITS SHALL BE THE RESPONSIBILITY OF THE OWNER OR CONTRACTOR.
- ALL MATERIALS USED IN PROJECT SHALL BE INSTALLED IN ACCORDANCE WITH 4. THE MANUFACTURER'S SPECIFICATIONS AND/OR GUIDELINES.
- THE ENGINEER HAS NOT BEEN RETAINED BY THE OWNER TO PROVIDE PERIODIC JOB INSPECTIONS OR JOB ADMINISTRATION AND SHALL NOT BE RESPONSIBLE FOR OMISSIONS OR CHANGES MADE IN THE FIELD WITHOUT PRIOR WRITTEN AUTHORIZATION.
- THE CONTRACTOR SHALL COORDINATE THE SCHEDULING OF ALL WORK WITH LIBRARY PERSONNEL TO ENSURE UNIMPEDED PUBLIC ACCESS DURING NORMAL BUSINESS HOURS.
- PUBLIC ACCESS TO FACILITY, DURING CONSTRUCTION SHALL BE THROUGH MAIN MEETING ROOM DOOR. EXISTING LIBRARY EXIT DOOR SHALL BE SECURED DURING CONSTRUCTION TO PREVENT ACCIDENTAL USE BY PUBLIC.

CONTRACTOR NOTE

- THE CONTRACTOR SHALL VERIFY ALL DIMENSIONS AND CONDITIONS AND SHALL ASSUME FULL AND TOTAL RESPONSIBILITY FOR THE ACCURACY OF THE SAME.
- IT IS A VIOLATION OF THE NEW YORK STATE EDUCATION LAW, ARTICLE 145, SECTION 7209 FOR ANY PERSON, UNLESS HE IS ACTING UNDER THE DIRECTION OF A LICENSED PROFESSIONAL ENGINEER OR LAND SURVEYOR, TO ALTER ANY ITEM IN ANY WAY. IF AN ITEM BEARING THE SEAL OF AN ENGINEER OR LAND SURVEYOR IS ALTERED, THE ALTERING ENGINEER OR LAND SURVEYOR SHALL AFFIX HIS SEAL AND THE NOTATION "ALTERED BY" FOLLOWED BY HIS SIGNATURE AND THE DATE OF SUCH ALTERATION, AND A SPECIFIC DESCRIPTION OF THE ALTERATION.
- PRIOR TO ANY CONSTRUCTION, THE CONTRACTOR SHALL BE FAMILIARIZED WITH THE PROPOSED WORK, HAVING EXAMINED THE SITE, LOCAL CONDITIONS EFFECTING THE COST OF THE WORK, THE CONTRACT DOCUMENTS, PLANS AND SPEC.'S. THE CONTRACTOR'S PRICE SHALL INCLUDE ALL TOOLS, EQUIPMENT, LABOR, MATERIALS AND SUPERVISION NECESSARY TO PERFORM THE WORK TO THE SATISFACTION OF THE OWNER.

SITE WORK

- PLACEMENT OF NEW FOOTINGS SHALL BE DONE WITHOUT THE DISTURBANCE OR UNDERMINING OF EXISTING FOOTINGS.
- FINISHED GRADING SHALL BE PERFORMED TO PROVIDE POSITIVE DRAINAGE AWAY FROM THE STRUCTURE.

CONCRETE

- ALL CONCRETE USED IN THE DECK POST FOOTINGS AND SLABS-ON-GRADE SHALL HAVE A MINIMUM COMPRESSIVE STRENGTH OF 3,000 PSI AT 28 DAYS.
- ALL REBAR SHALL BE GRADE 60 INTERMEDIATE GRADE BILLET STEEL, DEFORMED BARS, CONFORMING TO ASTM-65. INCLUDE SPACERS, CHAIRS, BOLSTERS, TIES AND OTHER DEVICES FOR PROPERLY PLACING, SPLICING, SUPPORTING, AND FASTENING.
- REINFORCEMENT SHALL BE CLEAN AND FREE FROM LOOSE RUST SCALE OR OTHER COATING.
- PROVIDE A MINIMUM OF 3" COVER ON ALL STEEL REINFORCEMENT. 4.
- ALL CONCRETE WORK SHALL BE COMPLETED IN ACCORDANCE WITH APPLICABLE ACI CODES.
- BOTTOM OF EXTERIOR POST FOOTINGS SHALL BE 4'-0" BELOW FINISHED GRADE AT ALL TIMES UNLESS SET ON SOLID ROCK.

LUMBER

- ALL STRUCTURAL LUMBER SHALL BE DOUGLAS FIR #2 OR BETTER, WITH A MINIMUM BENDING STRESS OF 1,250 PSI AND A MODULUS OF ELASTICITY OF 1,3000,000.
- LUMBER IN CONTACT WITH MASONRY, CONCRETE OR EXPOSED TO WEATHER SHALL BE PRESSURED TREATED AND KILN DRIED.
- LUMBER EXPOSED TO VIEW (i.e. POSTS, RAILS ETC.) SHALL BE STAINED WITH OIL-BASED, SEMI-TRANSPARENT STAIN. COLOR TO BE SELECTED BY OWNER FROM MANUFACTURER'S STANDARD COLOR CHART. MOISTURE CONTENT AND/ OR SEASONAL WEATHER CONDITIONS MAY DELAY APPLICATION OF STAINS INTO NEXT CALENDER YEAR.
- FRAMING SHALL BE ERECTED PLUMB, LEVEL, TRUE AND SECURELY FASTENED.
- BRIDGING SHALL BE SOLID WOOD 2" THICK AND THE SAME DEPTH AS MEMBER BRIDGED. BRIDGING SHALL BE PROVIDED AT MID-POINT OF SPANS OVER 8'-0" LONG.
- CONTRACTOR SHALL USE 'SIMPSON STRONG-TIE' STEEL JOIST/BEAM HANGERS ON ALL FLUSH FRAMED MEMBERS.
- CONTRACTOR SHALL USE ALUMINUM OR GALVANIZED NAILS OR SCREWS ON ALL EXTERIOR WORK.

ELECTRICAL

- ALL ELECTRICAL WORK SHALL BE PERFORMED AND PERMITTED IN STRICT ACCORDANCE WITH THE 'NATIONAL ELECTRIC CODE' (NEC)
- EXISTING ELECTRICAL SYSTEM SHALL BE EVALUATED BY QUALIFIED CONTRACTOR RELATIVE TO AVAILABLE CAPACITY AND REQUIRED SERVICE FOR NEW AUTOMATIC DOOR OPENER AND CONTROLS.
- GENERAL CONTRACTOR SHALL BE RESPONSIBLE FOR RETAINING THE SERVICES/ CONTRACT WITH A LICENSED ELECTRICIAN FOR THE WIRING, INSTALLATION ETC. OF ALL WORK RELATIVE TO THE ELECTRIC DOOR OPENER AND APPURTENANCES.



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PROJECT INFORMATION Project Number 14968.06 Client Name

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